

STANDARD DRAWING LEGEND

FOR ENTIRE PLAN SET
(NOT TO SCALE)

EXISTING NOTE	TYPICAL NOTE TEXT	PROPOSED NOTE	EXISTING NOTE	TYPICAL NOTE TEXT	PROPOSED NOTE
	ONSITE PROPERTY LINE / R.O.W. LINE			OVERHEAD WIRE	
	NEIGHBORING PROPERTY LINE / INTERIOR PARCEL LINE			UNDERGROUND TELEPHONE LINE	
	EASEMENT LINE			UNDERGROUND CABLE LINE	
	SETBACK LINE			STORM SEWER	
				SANITARY SEWER MAIN	
	CONCRETE CURB & GUTTER			HYDRANT	
				SANITARY MANHOLE	
				STORM MANHOLE	
	UTILITY POLE WITH LIGHT			WATER METER	
	POLE LIGHT			WATER VALVE	
	TRAFFIC LIGHT			GAS VALVE	
	UTILITY POLE			GAS METER	
	TYPICAL LIGHT			TYPICAL END SECTION	
	ACORN LIGHT			HEADWALL OR ENDWALL	
	TYPICAL SIGN			YARD INLET	
	PARKING COUNTS			CURB INLET	
				CLEAN OUT	
	CONTOUR LINE			ELECTRIC MANHOLE	
	SPOT ELEVATIONS			TELEPHONE MANHOLE	
				ELECTRIC BOX	
	SANITARY LABEL			ELECTRIC PEDESTAL	
	STORM LABEL			MONITORING WELL	
	SANITARY SEWER LATERAL			TEST PIT	
	UNDERGROUND WATER LINE			BENCHMARK	
	UNDERGROUND ELECTRIC LINE			BORING	
	UNDERGROUND GAS LINE				
	FLOODPLAIN LIMITS				

DEVELOPER

REDBRICK, LMD
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WASHINGTON, DC 20006
PHONE: 202-393-8090

PROJECT NARRATIVE:

THE SITE IS CURRENTLY OCCUPIED BY 18 TOTAL LOTS WITH THREE (3) EXISTING ONE-STORY BUILDINGS AND THREE (3) EXISTING TWO-STORY BUILDINGS AND MULTIPLE VACANT LOTS ON HOWARD ROAD, SE BETWEEN SUITLAND PARKWAY AND THE ANACOSTIA FREEWAY. THE PROPOSED PROJECT INCLUDES THE DEMOLITION OF THE EXISTING BUILDING AND SITE-RELATED FEATURES AND UTILITIES AND THE CONSTRUCTION OF FOUR (4) MIXED-USE MULTI-STORY BUILDINGS AND RECONSTRUCTION OF HOWARD ROAD, SE. THE PROPOSED PROJECT INCLUDES CONSTRUCTION OF NEW UTILITY INFRASTRUCTURE TO SERVICE THE DEVELOPMENT. THE PROJECT PROPOSES THE USE OF VARIABLE DEPTH GREEN ROOFS AND BIORETENTION TO MEET BOTH THE STORMWATER RETENTION VOLUME (SWRV) REQUIREMENTS AND THE GREEN AREA RATIO (GAR) REQUIREMENTS FOR ON-SITE.

GENERAL NOTES:

- THE PLAN IS BASED ON THE FOLLOWING DOCUMENTS AND INFORMATION:
 - SURVEY ENTITLED: "BOUNDARY & TOPOGRAPHIC SURVEY REDBRICK - POPLAR POINT A&T LOTS 957, 969, 971, 982, 986, 988, 1020, 1025-1031, 1036 & 1047 SQUARE 5860 A&T LOTS 951 & 957 SQUARE 5861, LOTS 79, 82-86 SQUARE 5861 631-821 600-692 HOWARD ROAD, S.E. WASHINGTON, DISTRICT OF COLUMBIA" PREPARED BY: BOHLER ENGINEERING PROJECT NO.:SRW152035 DATE: 06/03/2016
 - DIGITAL ARCHITECTURAL PLANS: ENTITLED: "2017-10-02-HOK.DWG," PREPARED BY: HOK ARCHITECTURE, DATED: 10/02/17.
- LOCATION OF ALL UNDERGROUND UTILITIES ARE APPROXIMATE. ALL LOCATIONS AND SIZES ARE BASED ON UTILITY MARK OUTS, ABOVE GROUND STRUCTURES THAT WERE VISIBLE & ACCESSIBLE IN THE FIELD, AND THE MAPS AS LISTED IN THE REFERENCES AVAILABLE AT THE TIME OF THE SURVEY. AVAILABLE AS-BUILT PLANS AND UTILITY MARK OUT DOES NOT ENSURE MAPPING OF ALL UNDERGROUND UTILITIES AND STRUCTURES. BEFORE ANY EXCAVATION IS TO BEGIN, ALL UNDERGROUND UTILITIES SHOULD BE VERIFIED AS TO THEIR LOCATION, SIZE, AND TYPE BY THE PROPER UTILITY COMPANIES.

SHEET INDEX

SHEET TITLE	SHEET NUMBER
COVER SHEET	C1
EX. CONDITIONS/DEMOLITION PLAN	C2
SITE PLAN	C3
UTILITY PLAN	C4
STORMWATER MANAGEMENT/GAR PLAN	C5
EROSION AND SEDIMENT CONTROL PLAN	C6
TRUCK TURN	C7
BOUNDARY AND TOPOGRAPHIC SURVEY	SHEETS 1 - 6

PROJECT NAME:

COLUMBIAN QUARTER PUD



BOHLERTM

DC

1331 PENNSYLVANIA AVE., NW, STE. 1250 WASHINGTON, DC 20004
PHONE: (202) 524-5700

SHEET TITLE:

COVER SHEET
SHEET C1

SCALE:

DATE:

N/A

CAD ID:

10/04/17



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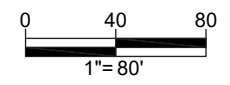
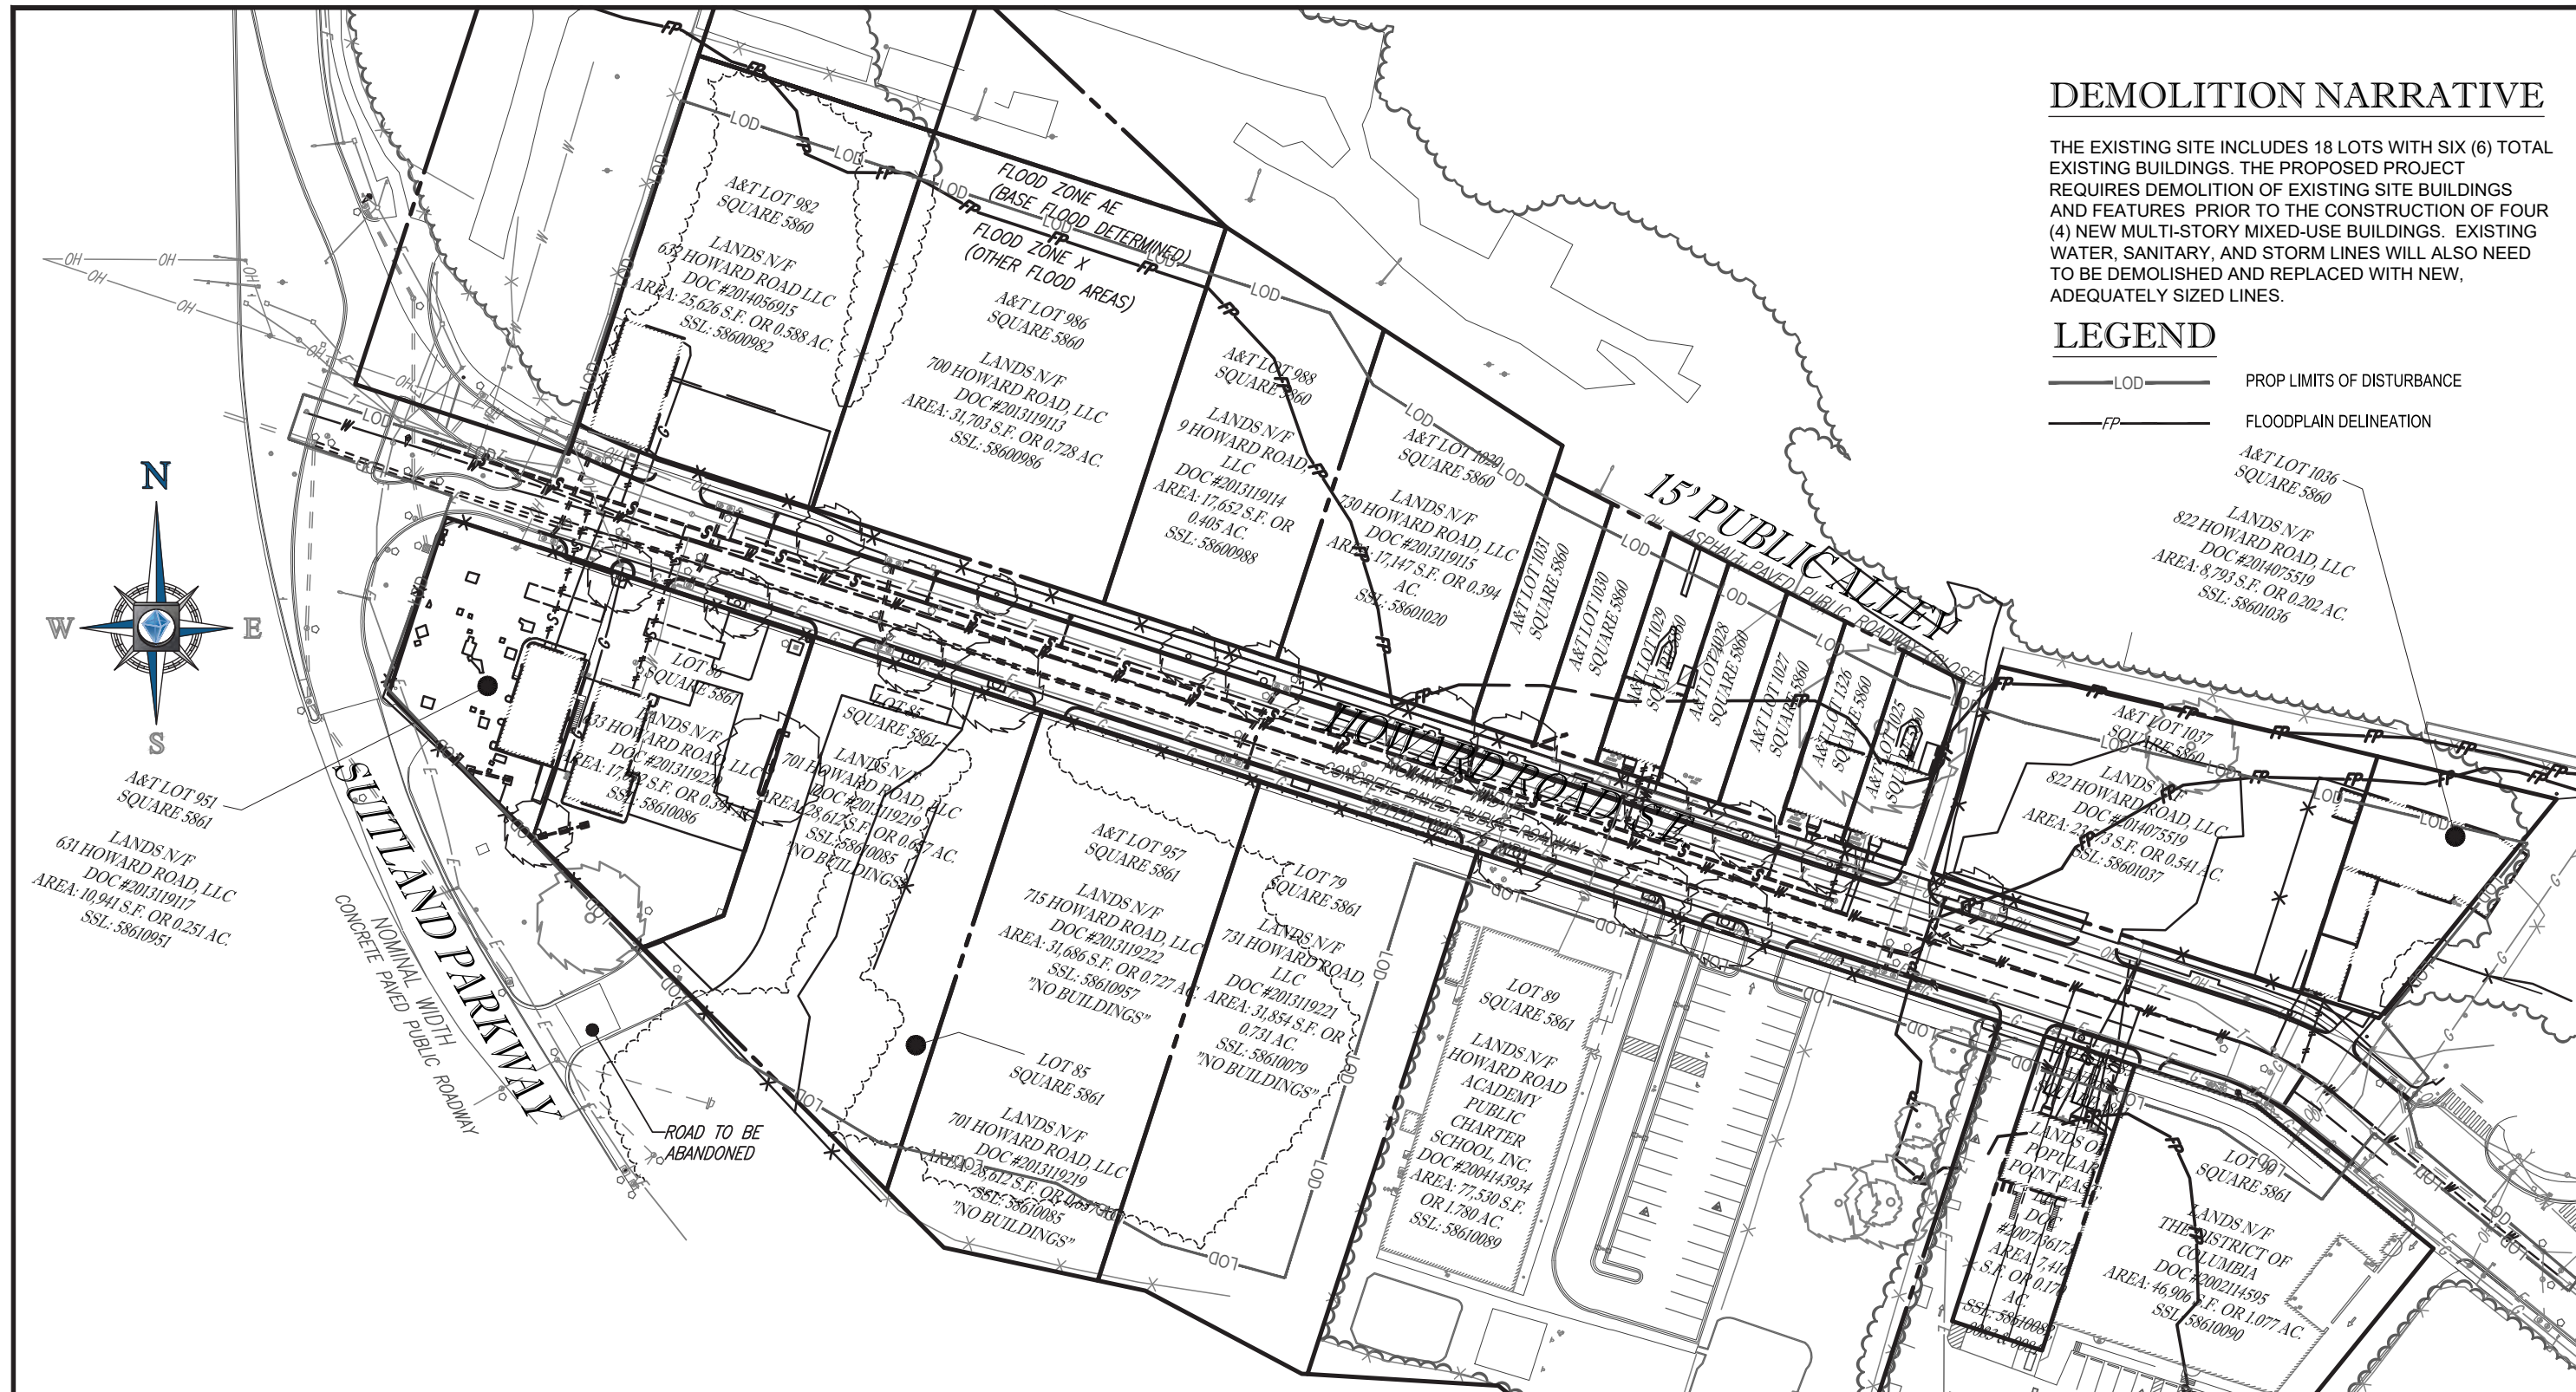
SD1 DC152035


DEMOLITION NARRATIVE

THE EXISTING SITE INCLUDES 18 LOTS WITH SIX (6) TOTAL EXISTING BUILDINGS. THE PROPOSED PROJECT REQUIRES DEMOLITION OF EXISTING SITE BUILDINGS AND FEATURES PRIOR TO THE CONSTRUCTION OF FOUR (4) NEW MULTI-STORY MIXED-USE BUILDINGS. EXISTING WATER, SANITARY, AND STORM LINES WILL ALSO NEED TO BE DEMOLISHED AND REPLACED WITH NEW, ADEQUATELY SIZED LINES.

LEGEND


-  PROP LIMITS OF DISTURBANCE
-  FLOODPLAIN DELINEATION




PROJECT NAME: COLUMBIAN QUARTER PUD	
 BOHLER DC	SHEET TITLE: EXISTING CONDITIONS AND DEMOLITION PLAN SHEET C2
1331 PENNSYLVANIA AVE., NW, STE. 1250 WASHINGTON, DC 20004 PHONE: (202) 524-5700	SCALE: 1" = 80' DATE: 10/04/17 CAD ID: SS1 PROJECT NUMBER: DC152035

SITE NARRATIVE

THE PROJECT PROPOSES FOUR (4) MULTI-STORY MIXED-USE BUILDINGS.

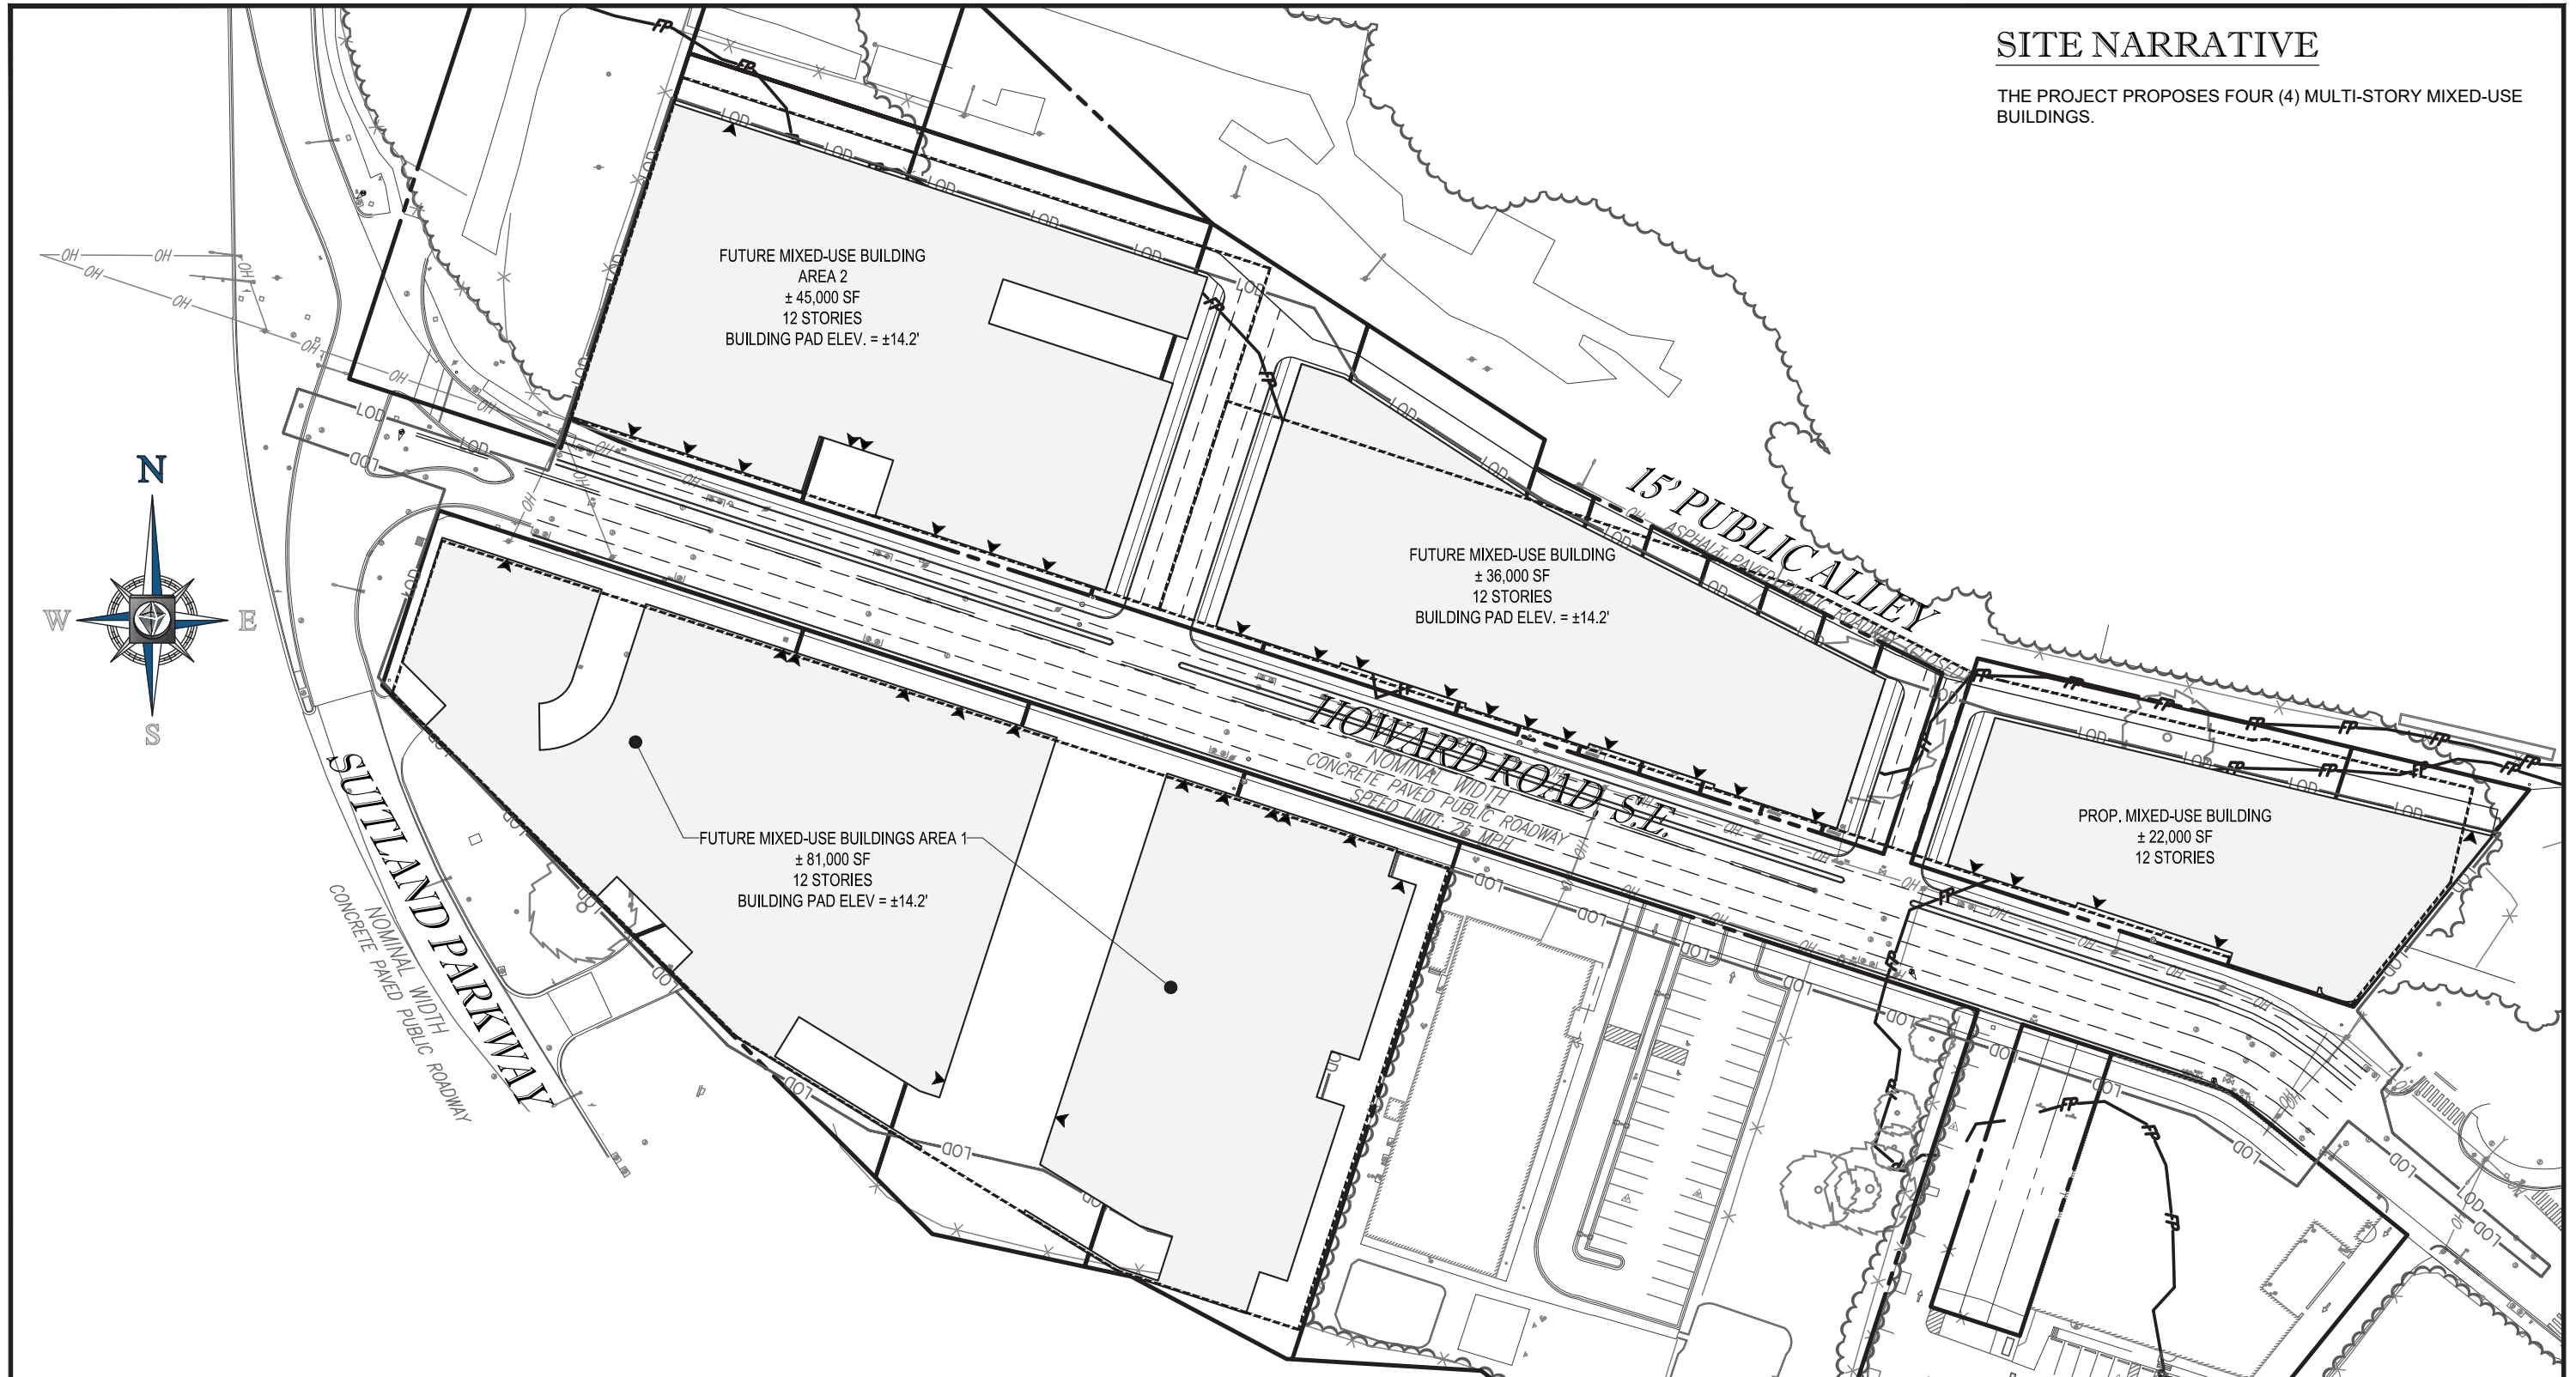

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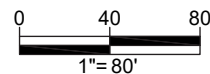
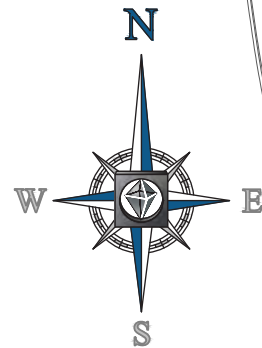
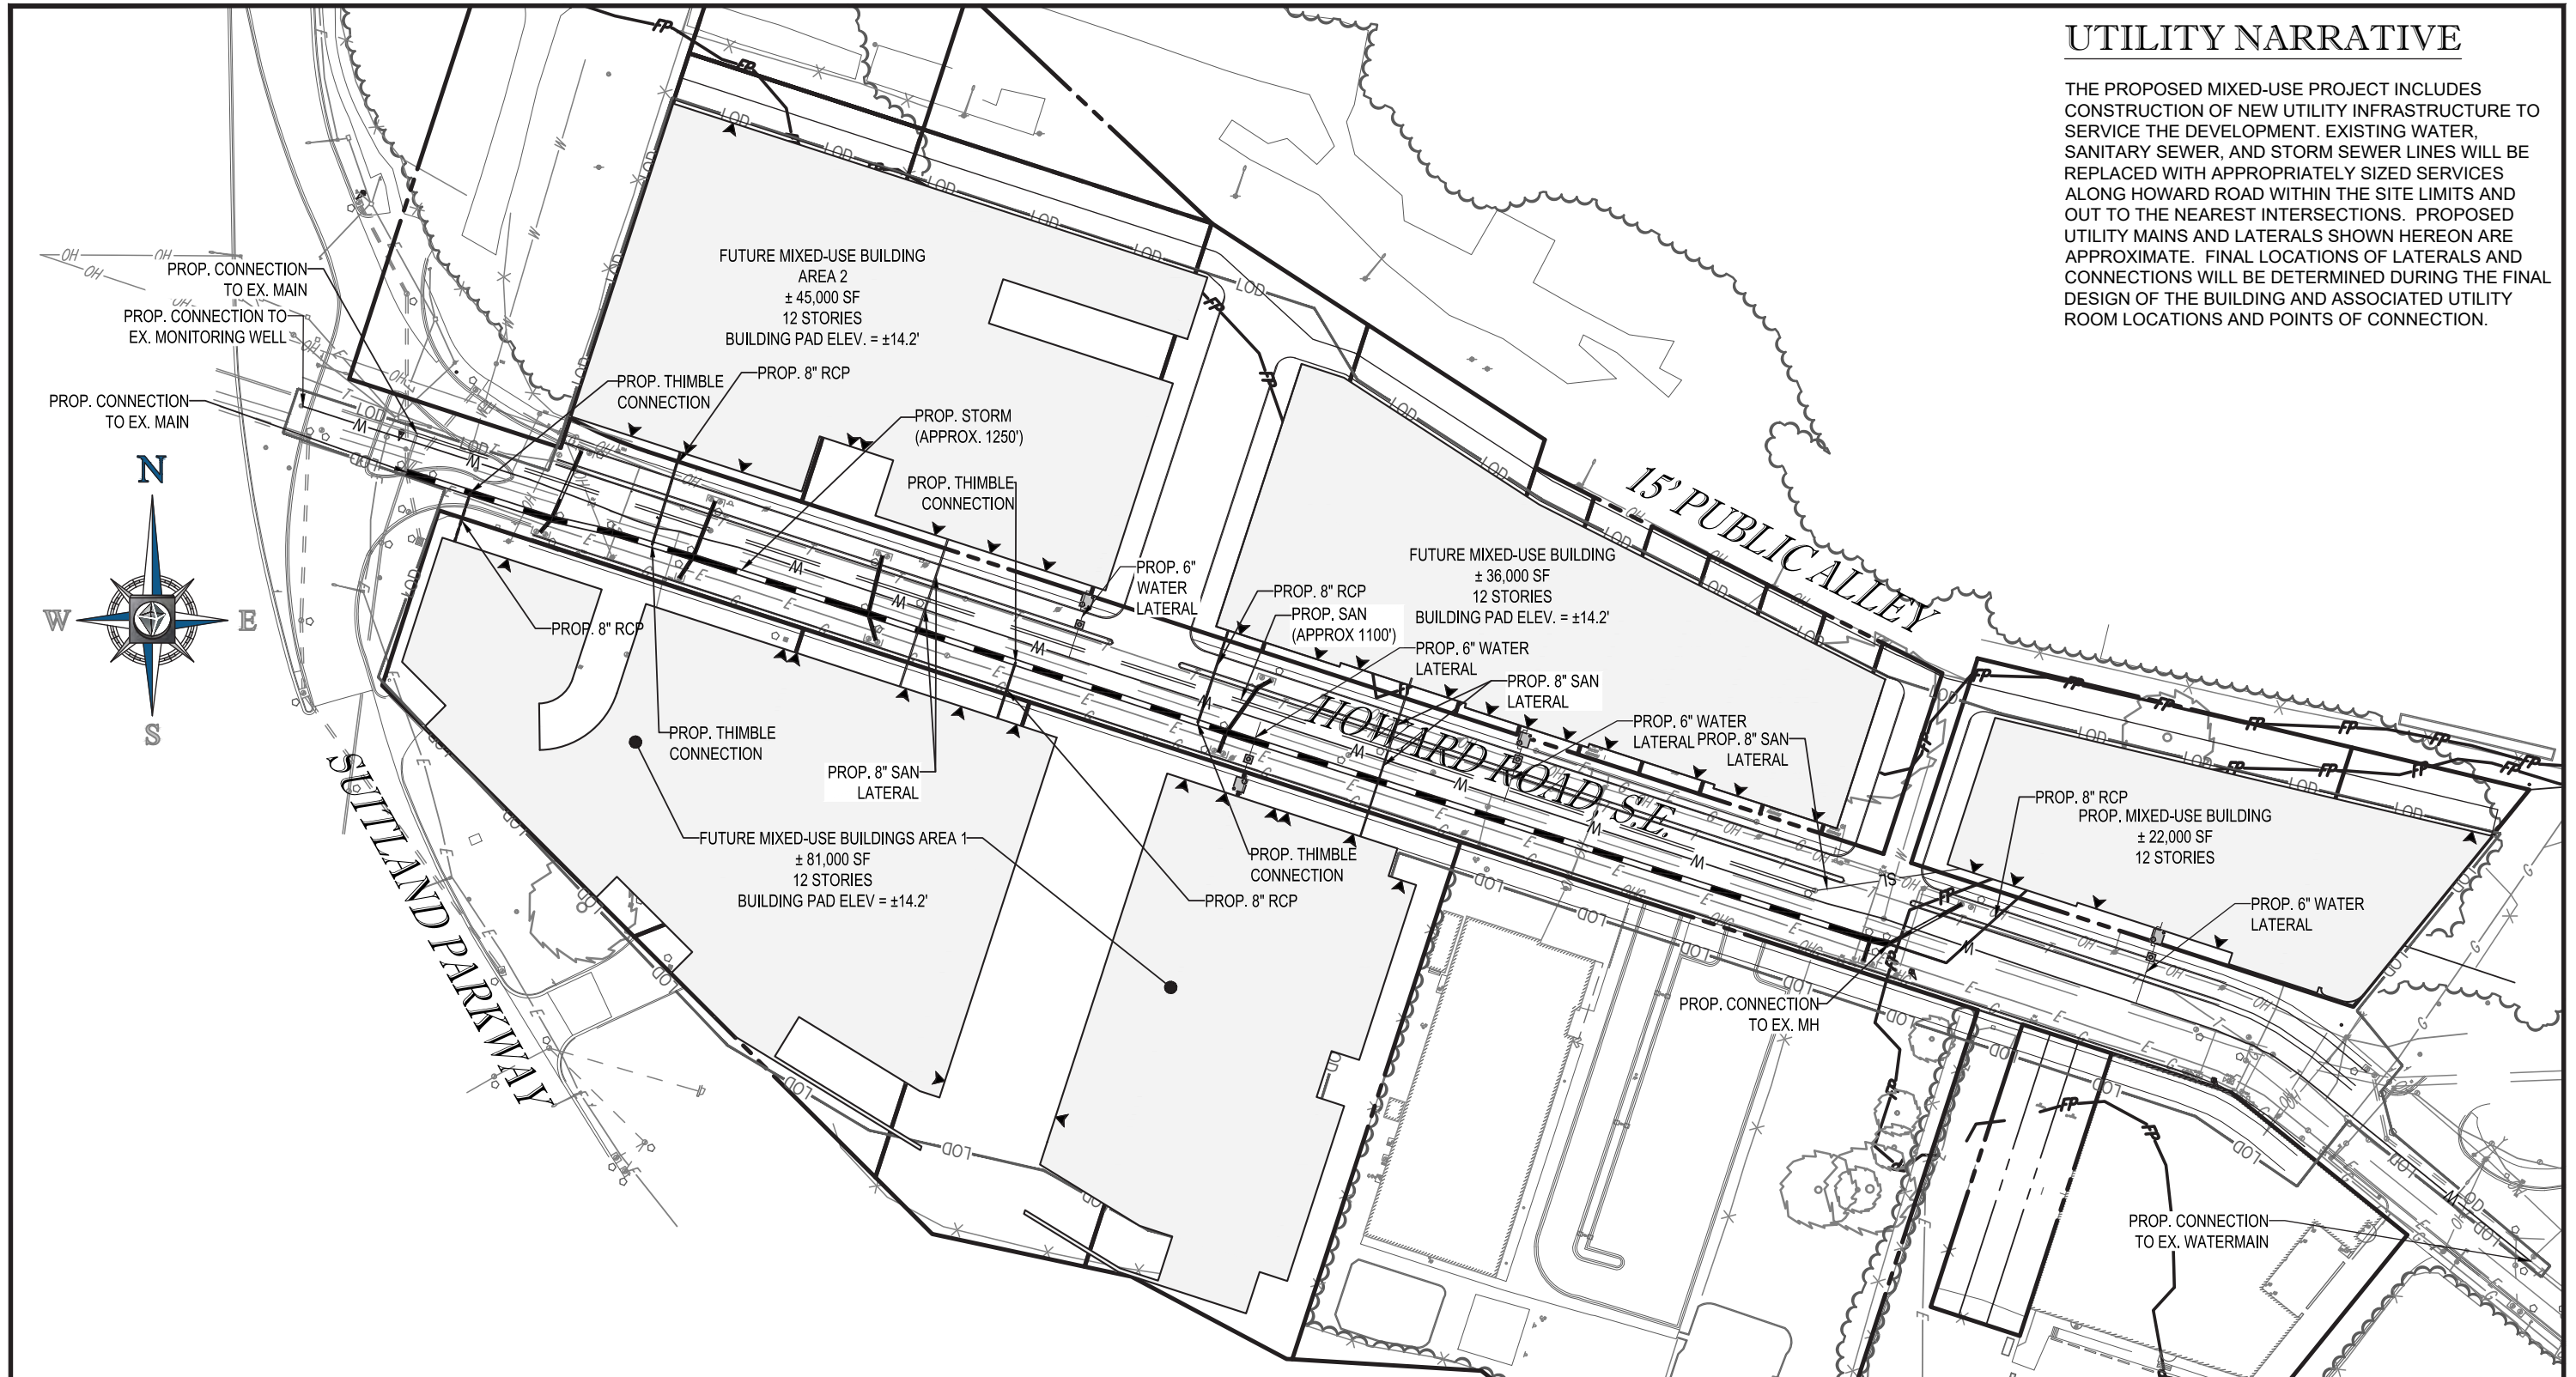
1331 PENNSYLVANIA AVE., NW, STE. 1250 WASHINGTON, DC 20004
PHONE: (202) 524-5700

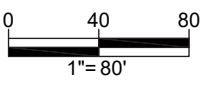SHEET TITLE: SITE PLAN
SHEET C3

SCALE: 1" = 80'	DATE: 10/04/17	CAD ID: SS1	PROJECT NUMBER: DC152035
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UTILITY NARRATIVE

THE PROPOSED MIXED-USE PROJECT INCLUDES CONSTRUCTION OF NEW UTILITY INFRASTRUCTURE TO SERVICE THE DEVELOPMENT. EXISTING WATER, SANITARY SEWER, AND STORM SEWER LINES WILL BE REPLACED WITH APPROPRIATELY SIZED SERVICES ALONG HOWARD ROAD WITHIN THE SITE LIMITS AND OUT TO THE NEAREST INTERSECTIONS. PROPOSED UTILITY MAINS AND LATERALS SHOWN HEREON ARE APPROXIMATE. FINAL LOCATIONS OF LATERALS AND CONNECTIONS WILL BE DETERMINED DURING THE FINAL DESIGN OF THE BUILDING AND ASSOCIATED UTILITY ROOM LOCATIONS AND POINTS OF CONNECTION.



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SHEET TITLE: UTILITY PLAN
SHEET C4

SCALE: 1" = 80'	DATE: 10/04/17	CAD ID: SS1	PROJECT NUMBER: DC152035
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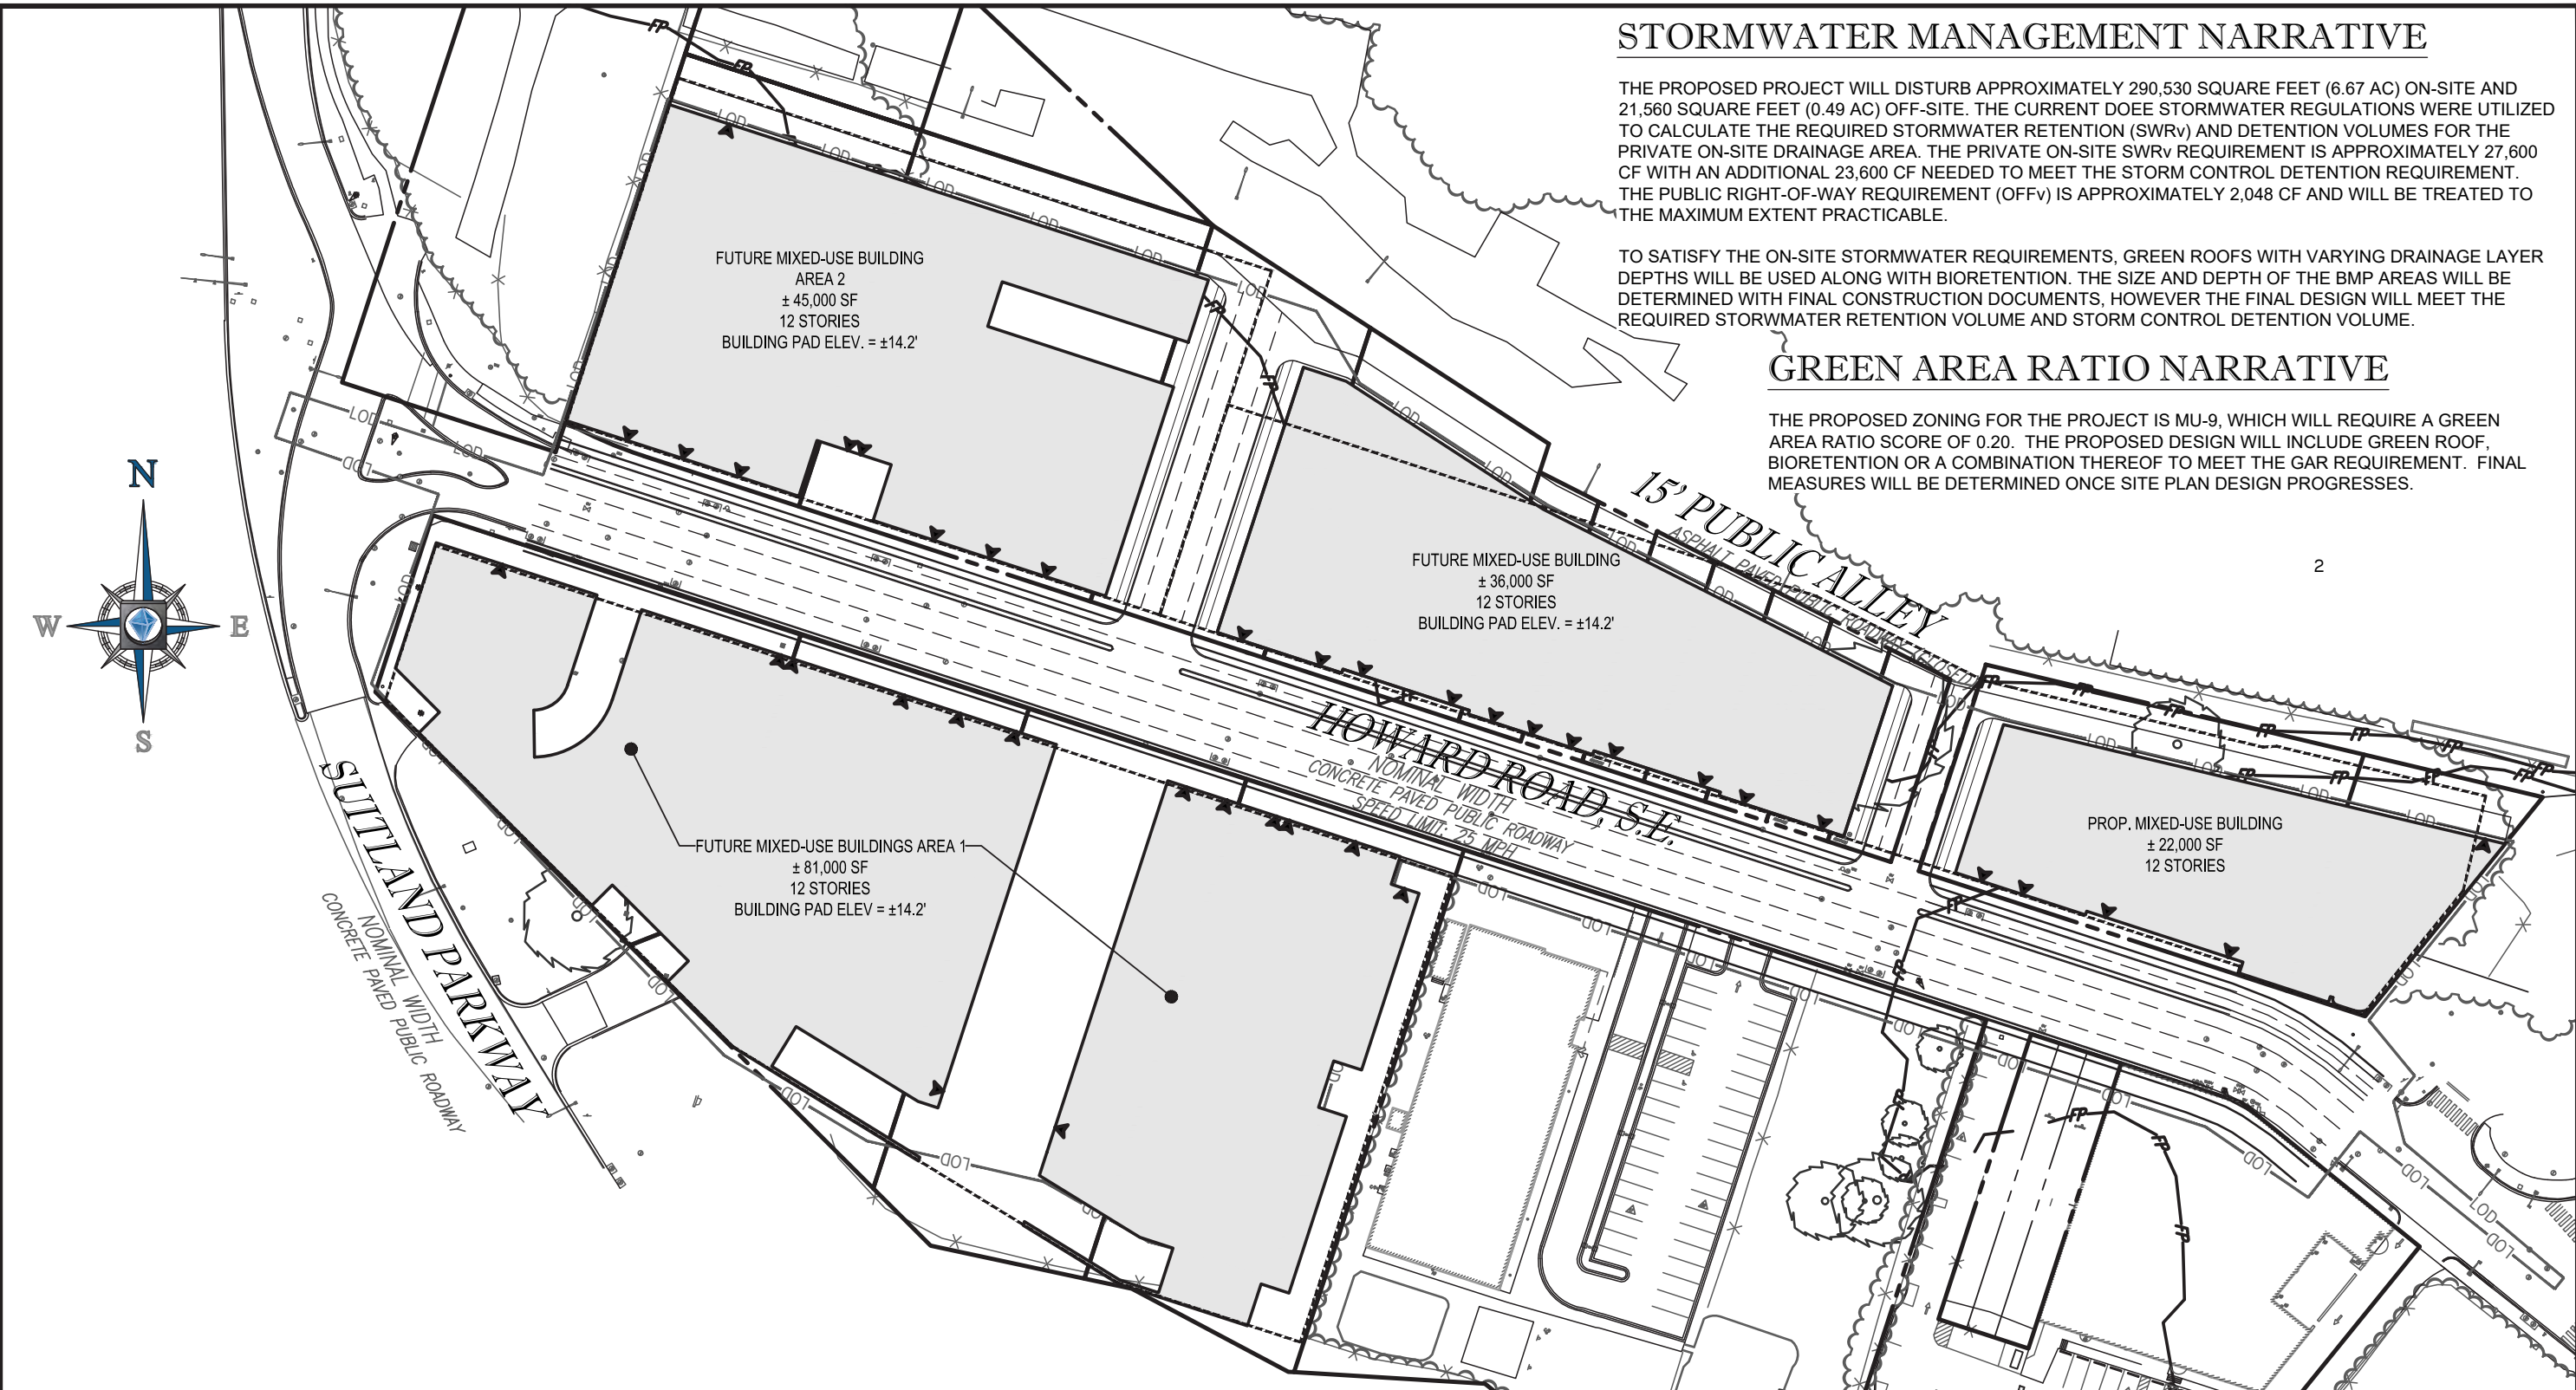
STORMWATER MANAGEMENT NARRATIVE

THE PROPOSED PROJECT WILL DISTURB APPROXIMATELY 290,530 SQUARE FEET (6.67 AC) ON-SITE AND 21,560 SQUARE FEET (0.49 AC) OFF-SITE. THE CURRENT DOEE STORMWATER REGULATIONS WERE UTILIZED TO CALCULATE THE REQUIRED STORMWATER RETENTION (SWRV) AND DETENTION VOLUMES FOR THE PRIVATE ON-SITE DRAINAGE AREA. THE PRIVATE ON-SITE SWRV REQUIREMENT IS APPROXIMATELY 27,600 CF WITH AN ADDITIONAL 23,600 CF NEEDED TO MEET THE STORM CONTROL DETENTION REQUIREMENT. THE PUBLIC RIGHT-OF-WAY REQUIREMENT (OFFV) IS APPROXIMATELY 2,048 CF AND WILL BE TREATED TO THE MAXIMUM EXTENT PRACTICABLE.


TO SATISFY THE ON-SITE STORMWATER REQUIREMENTS, GREEN ROOFS WITH VARYING DRAINAGE LAYER DEPTHS WILL BE USED ALONG WITH BIORETENTION. THE SIZE AND DEPTH OF THE BMP AREAS WILL BE DETERMINED WITH FINAL CONSTRUCTION DOCUMENTS. HOWEVER THE FINAL DESIGN WILL MEET THE REQUIRED STORMWATER RETENTION VOLUME AND STORM CONTROL DETENTION VOLUME.

GREEN AREA RATIO NARRATIVE

THE PROPOSED ZONING FOR THE PROJECT IS MU-9, WHICH WILL REQUIRE A GREEN AREA RATIO SCORE OF 0.20. THE PROPOSED DESIGN WILL INCLUDE GREEN ROOF, BIORETENTION OR A COMBINATION THEREOF TO MEET THE GAR REQUIREMENT. FINAL MEASURES WILL BE DETERMINED ONCE SITE PLAN DESIGN PROGRESSES.




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SHEET TITLE: STORMWATER MANAGEMENT/GAR PLAN			
SHEET C5			
SCALE: 1" = 80'	DATE: 10/04/17	CAD ID: DA1	PROJECT NUMBER: DC152035

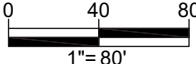



EROSION AND SEDIMENT CONTROL LEGEND		
TITLE	KEY	SYMBOL
SAFETY FENCE	SAF	
SILT FENCE	SF	
CURB INLET PROTECTION	CIP	
STABILIZED CONSTRUCTION ENTRANCE	SCE	
LIMIT OF DISTURBANCE	LOD	

EROSION & SEDIMENT CONTROL NARRATIVE

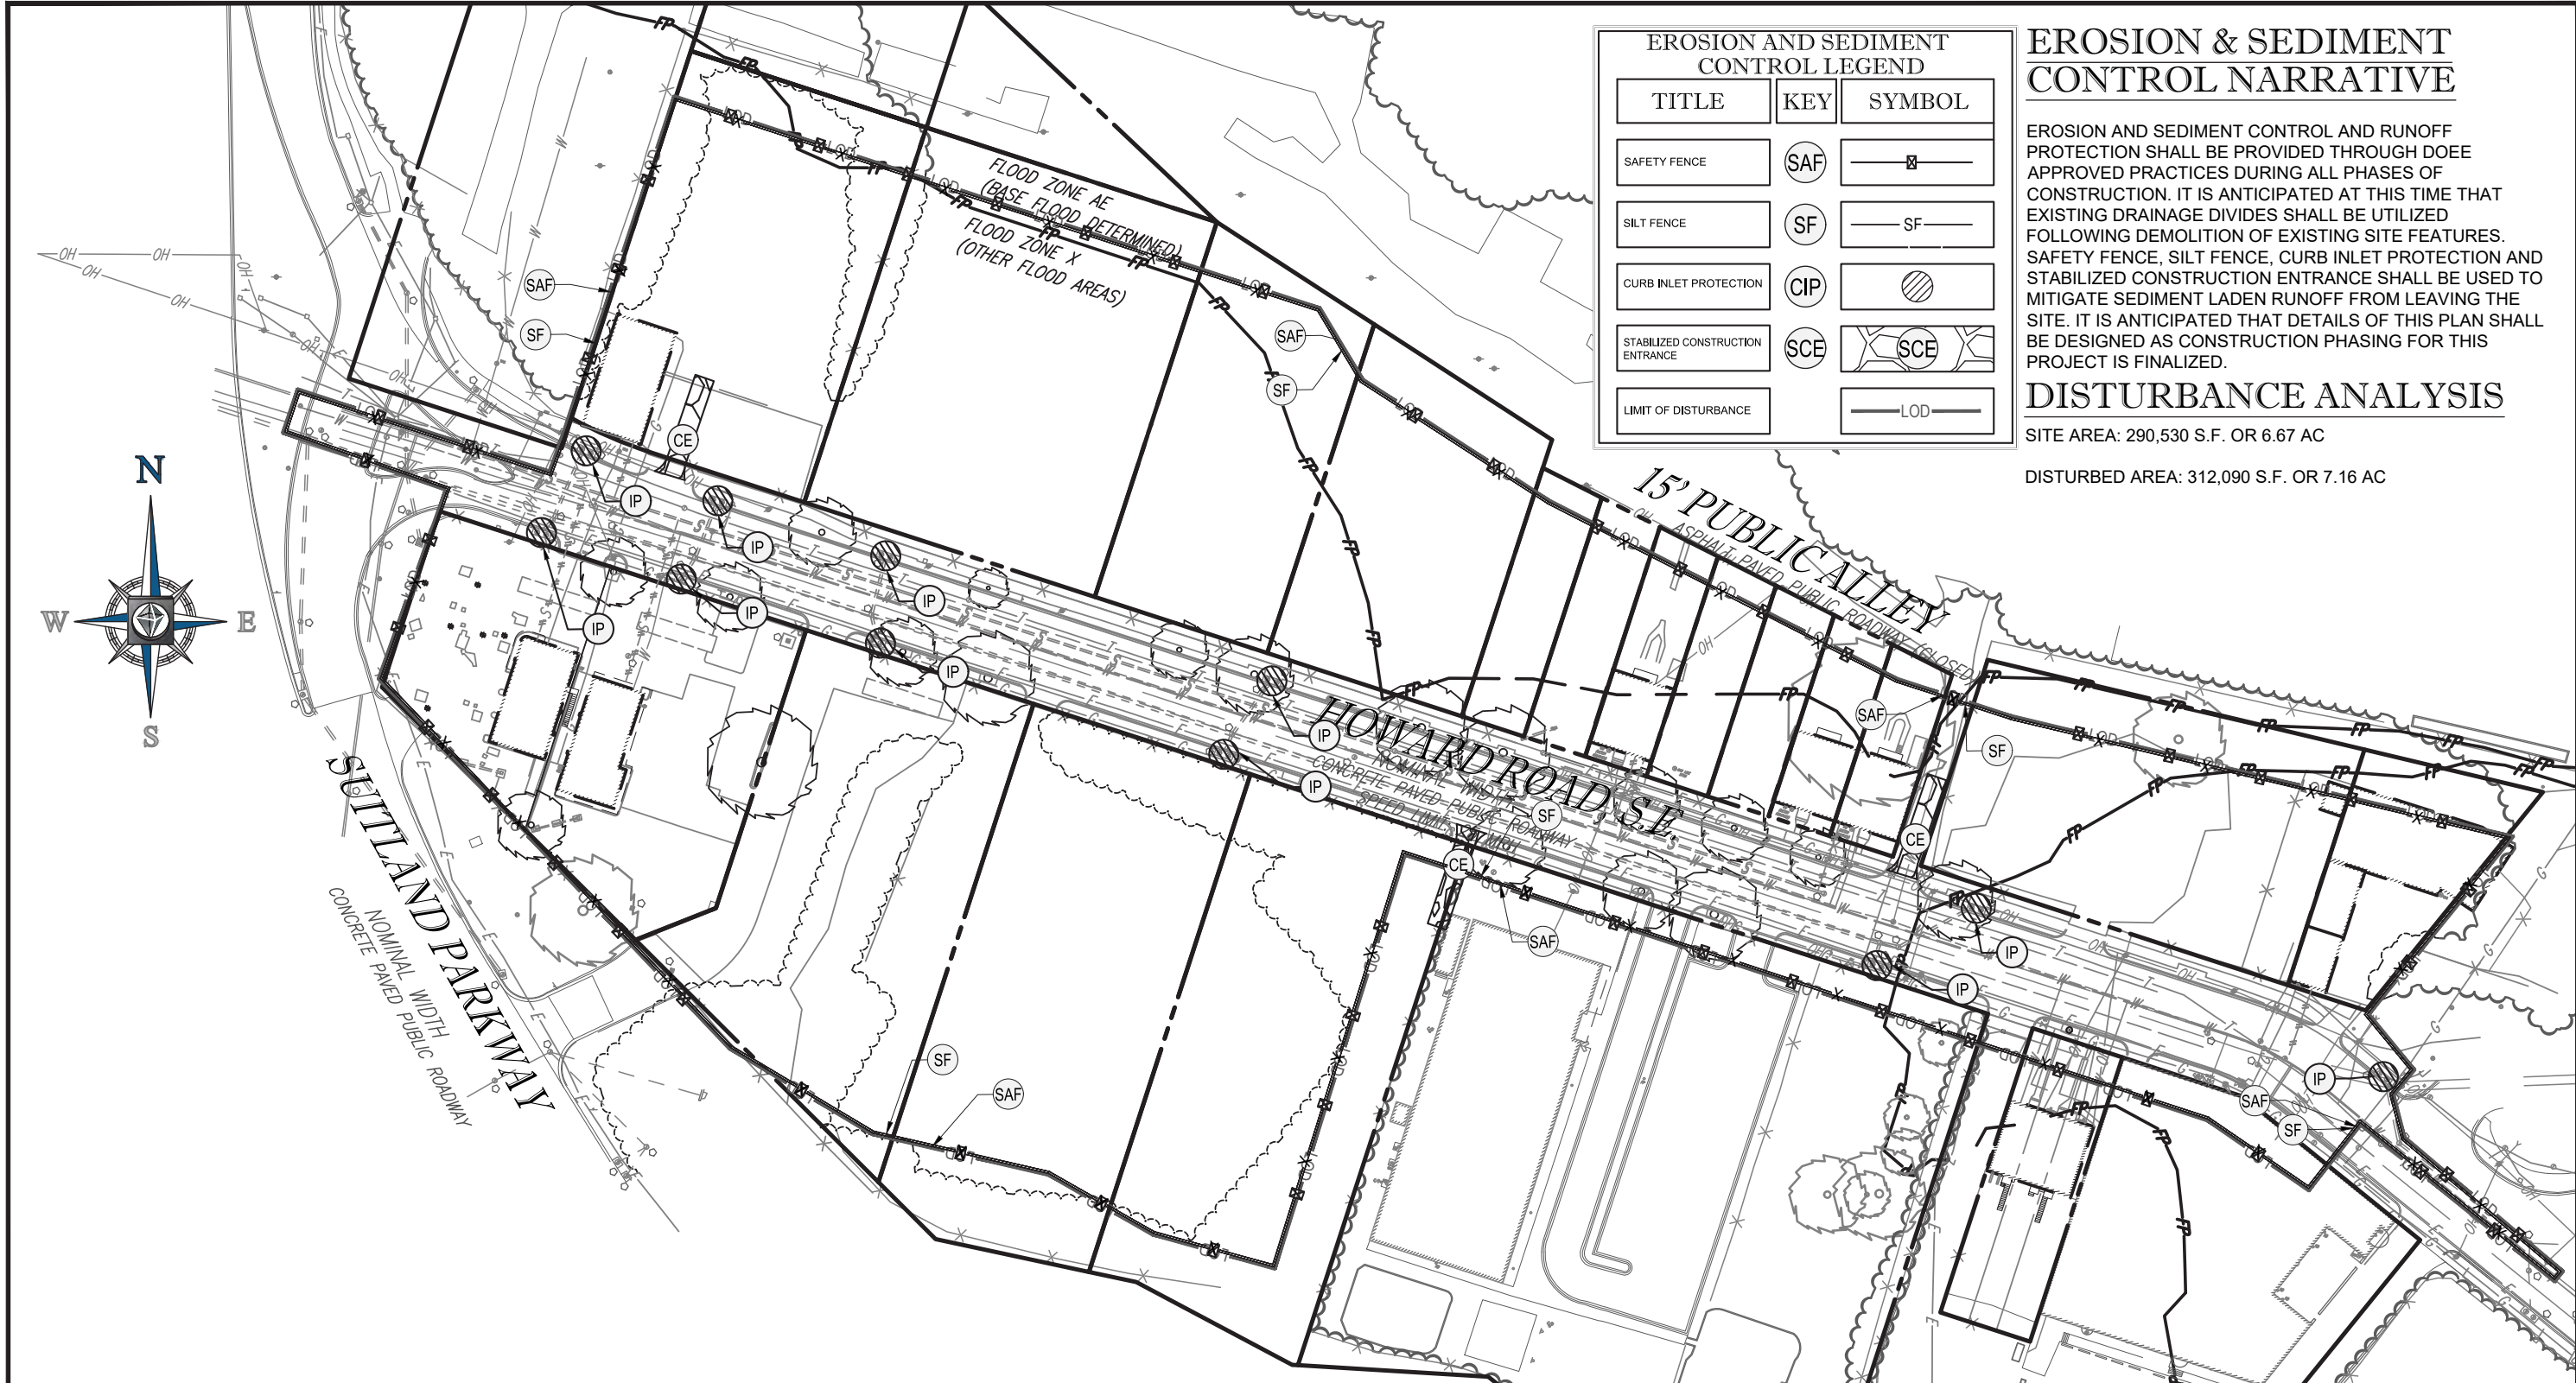EROSION AND SEDIMENT CONTROL AND RUNOFF PROTECTION SHALL BE PROVIDED THROUGH DOEE APPROVED PRACTICES DURING ALL PHASES OF CONSTRUCTION. IT IS ANTICIPATED AT THIS TIME THAT EXISTING DRAINAGE DIVIDES SHALL BE UTILIZED FOLLOWING DEMOLITION OF EXISTING SITE FEATURES. SAFETY FENCE, SILT FENCE, CURB INLET PROTECTION AND STABILIZED CONSTRUCTION ENTRANCE SHALL BE USED TO MITIGATE SEDIMENT LADEN RUNOFF FROM LEAVING THE SITE. IT IS ANTICIPATED THAT DETAILS OF THIS PLAN SHALL BE DESIGNED AS CONSTRUCTION PHASING FOR THIS PROJECT IS FINALIZED.

DISTURBANCE ANALYSIS

SITE AREA: 290,530 S.F. OR 6.67 AC
 DISTURBED AREA: 312,090 S.F. OR 7.16 AC

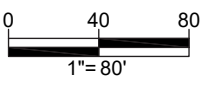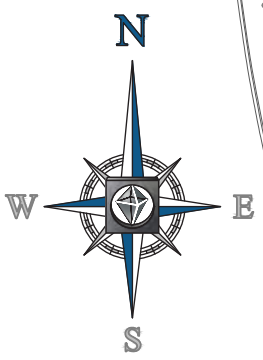

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SHEET TITLE: EROSION AND SEDIMENT CONTROL
 SHEET C6

SCALE: 1" = 80'	DATE: 10/04/17	CAD ID: SS1	PROJECT NUMBER: DC152035
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